


ROOM FINISH SCHEDULE - SIMILAR FOR ALL UNITS						
ROOM	FLOOR	BASE	CEILING	HALLS	TRIM	REMARKS
BASMENT	CONC.	—	UNPAINTED	2" x 4" STUDS	—	CEILING STUDS UNPAINTED
OUTDOOR ENTRY	CONC.	—	RYNWOOD PAINTED	2" x 4" STUDS	—	NO FINISHES RYWOOD PAINTS PAINTED
LIVING RM.	HARDWOOD FLOOR	WOOD PAINTED	CONC. PAINTED	CONC. PAINTED	WOOD PAINTED	
DINING RM.	"	"	"	"	"	
KITCHEN	"	"	"	"	"	KITCHEN CUPBDS PAINTED
RESTROOM	HARDWOOD FLOOR	WOOD PAINTED	CONC. PAINTED	CONC. PAINTED	WOOD PAINTED	
BATH	"	"	"	"	"	
BEDROOMS	"	"	"	"	"	
BATHROOM	"	"	"	"	"	
HALL	"	"	"	"	"	
DECK	CONC.	WOOD	RYNWOOD PAINTED	RYNWOOD PAINTED	WOOD PAINTED	

DOORS:
 ALL INTERIOR DOORS 1 3/4" HOLLOW CORE WITH
 MANOBAVY FACE VENEER (R.H. UNITS)
 ALL EXTERIOR DOORS 1 3/4" SOLID CORE WITH
 RE VENEER CARBIDE RM DOOR 1 3/4" H.C. WITH FIRE VENEER
 ALL SLIDING CLOSET DOORS 1 3/4" x 6'-8" x 5'-0" (FAM)
 HOLLOW CORE (R.H. UNITS)
 ALL INTERIOR DOORS TO HAVE STAIN FINISH
 ALL EXTERIOR DOORS TO HAVE ALUMINUM AND GLASS
 STORM DOOR WITH INTEGRAL SCREENED CASHIEL


WINDOW SCHEDULE		
TYPE	SIZE	DESCRIPTION
1	8'-4" x 4'-3 1/4"	HORIZONTAL SLIDING GLASS IN WOOD
2	2'-4" x 6'-7 1/4"	INTEGRAL FLY SCREEN
3	8'-4" x 6'-13 1/4"	"
4	5'-8" x 5'-4"	WALL CLAMPED HORIZONTAL
5	1'-6" x 5'-4"	SLIDING GLASS, INTEGRAL FLY SCREEN
6	5'-8" x 6'-9"	BASEMENT WINDOW (OPENING)

- NOTES:**
1. ALL FLOOR JOISTS TO BE NO. 1 CONSTRUCTION GRADE STUKE OR REMLOCK
 2. ALL WIND ASBESTOS TILE TO BE 0-08 DUBBS
 3. EXHAUST FANS TO BE PROVIDED AT INTERIOR BATH ROOMS
 4. GRAB BAR UP TO 4'-0" HIGH IN BATH RM AREA
 5. MEDICINE CABINET TO BE SURFACE MOUNTED
 6. SOAP & GLAS TO BE INSTALLED IN BATH RM AREA
 7. TOWEL BAR WALL MOUNTED IN BATHROOM


NOTE: SEE ALTERNATE QUOTATION TO CHANGE ALL
 HARDWOOD FLOORS TO L.P.

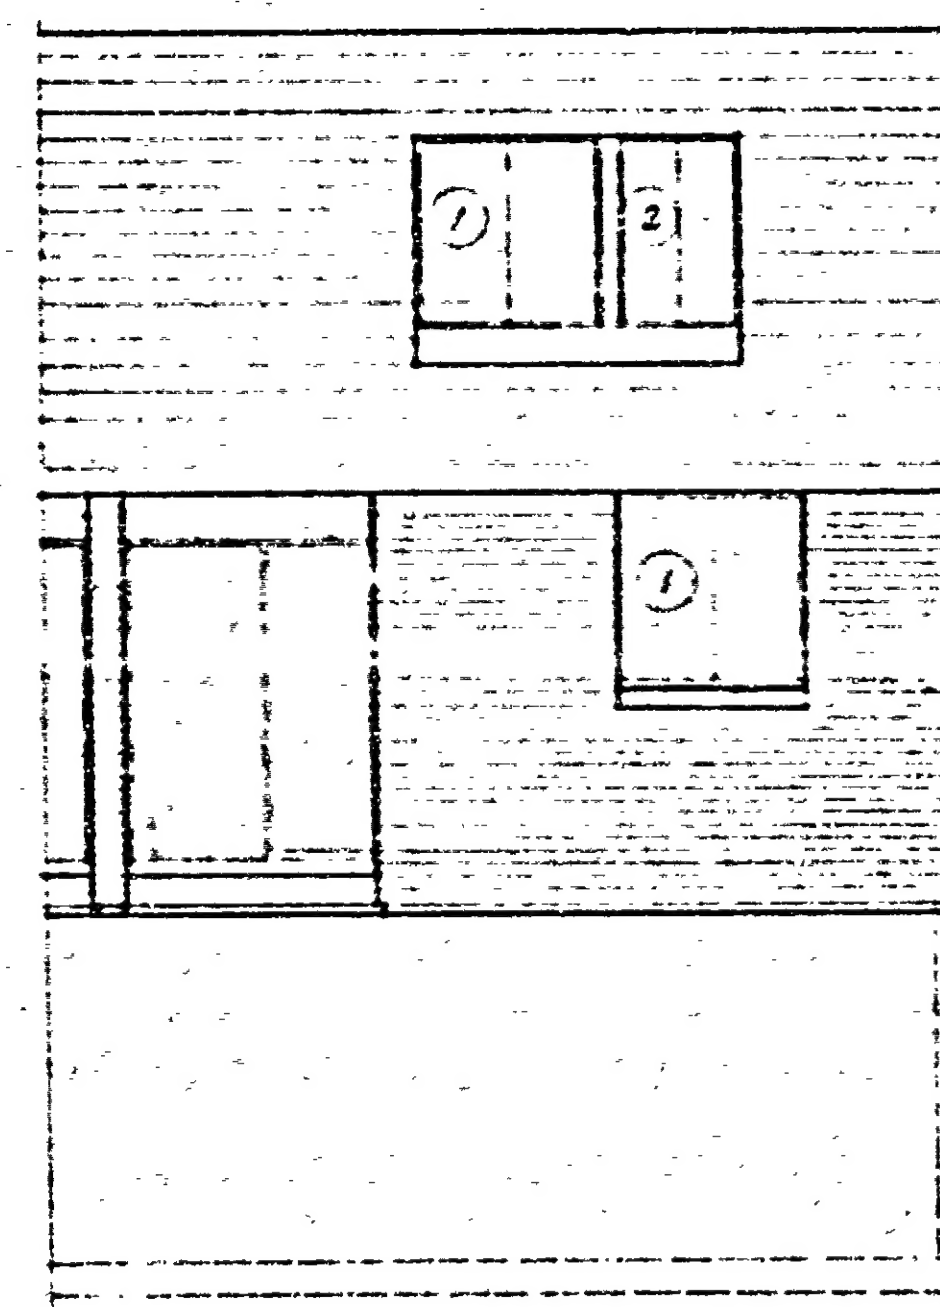


FRONT ELEVATION
 THREE BEDROOM UNITS

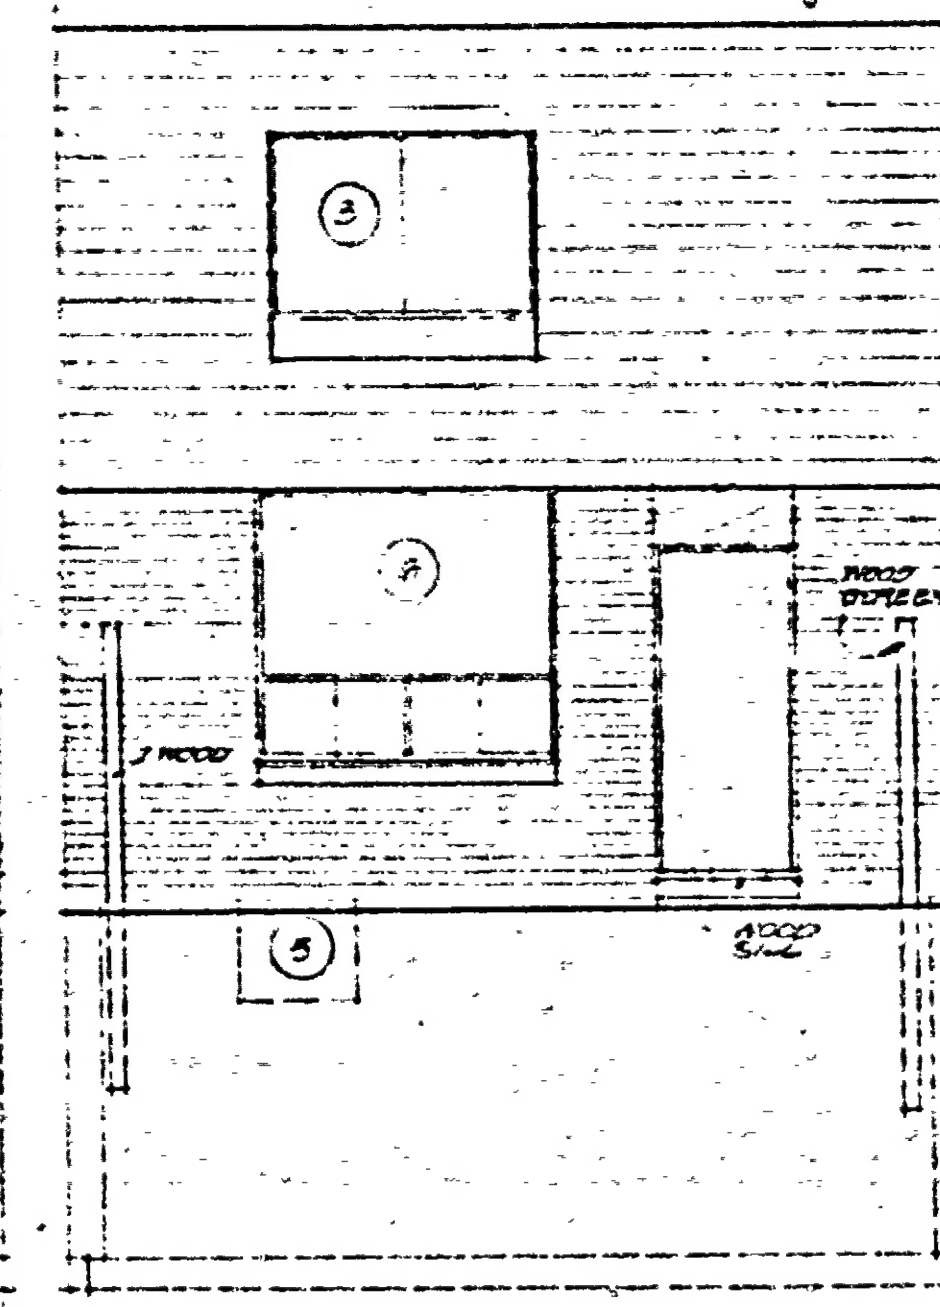


BACK ELEVATION

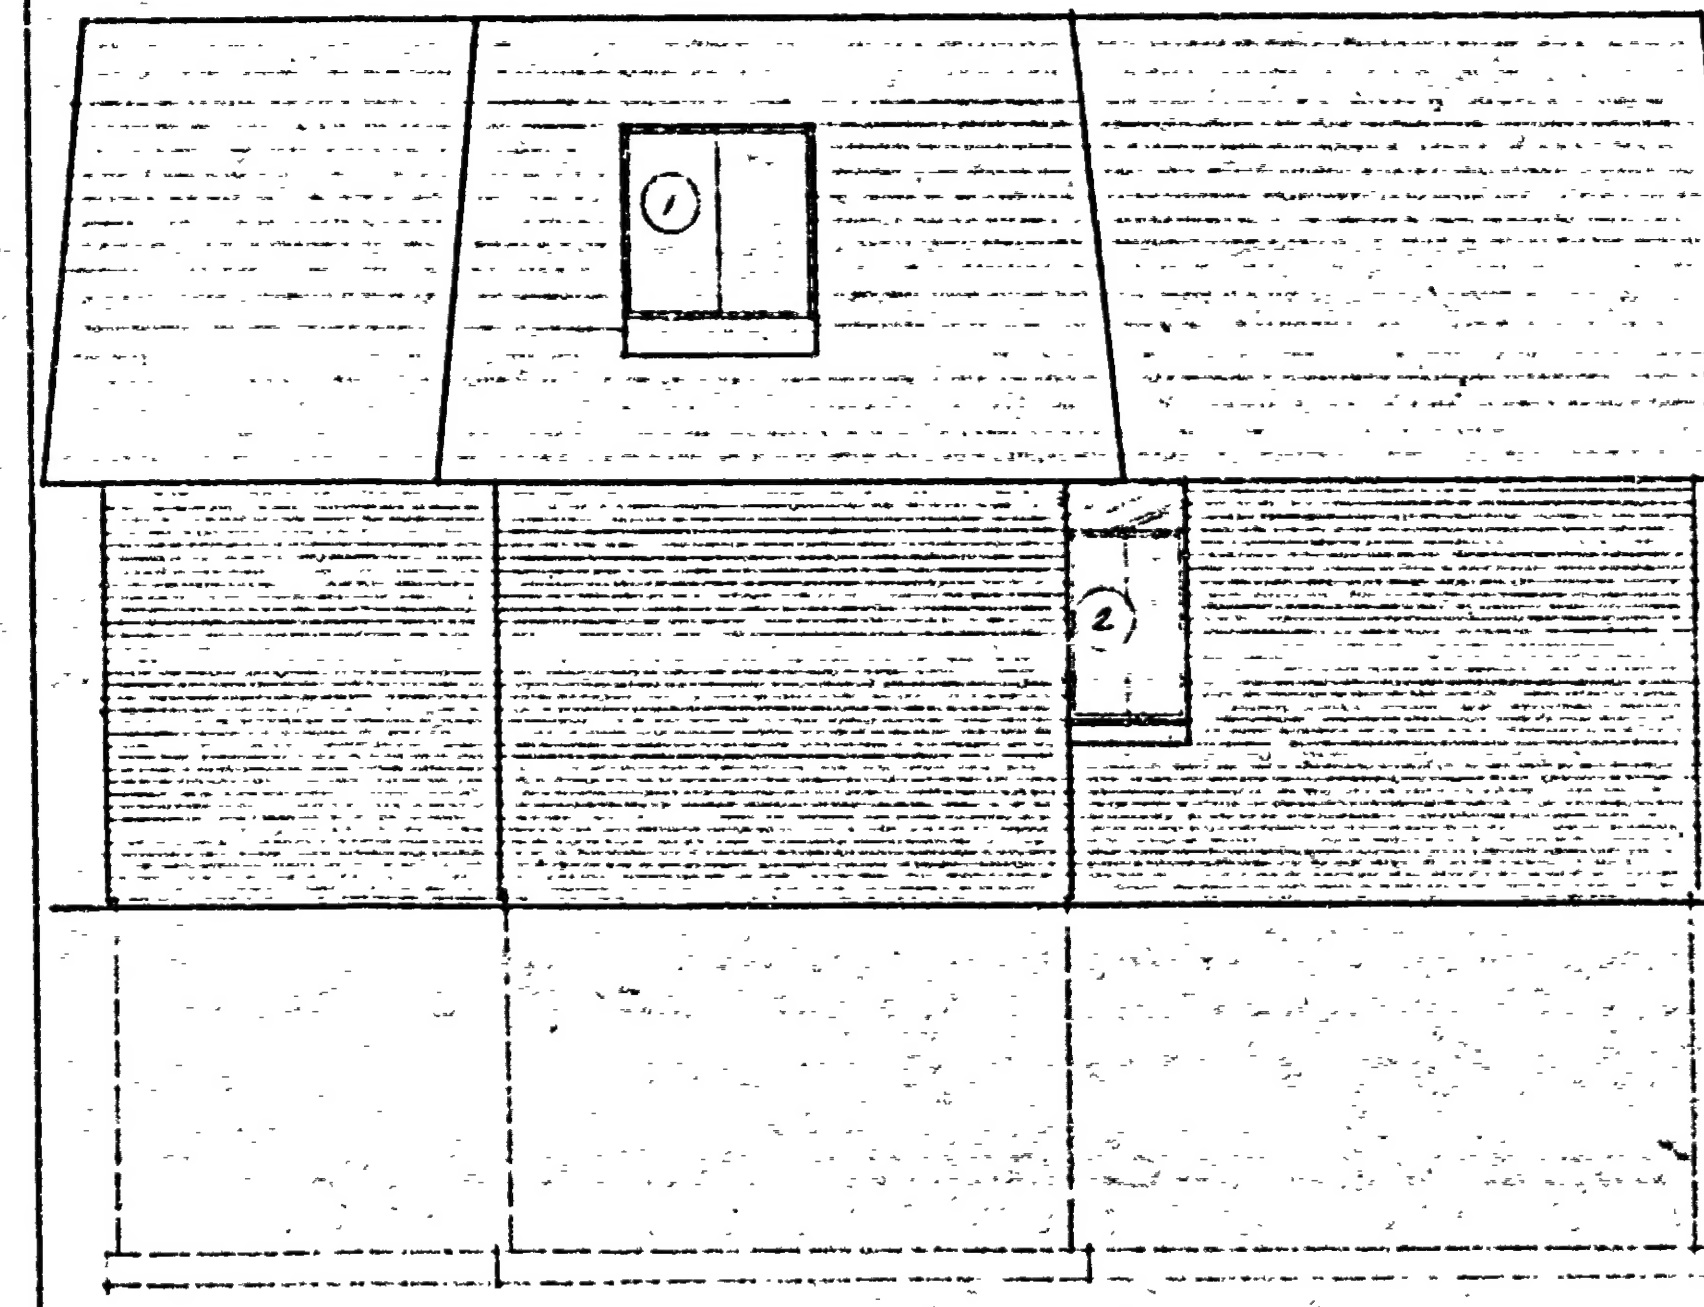


SIDE ELEVATION
 FIVE BEDROOM UNITS

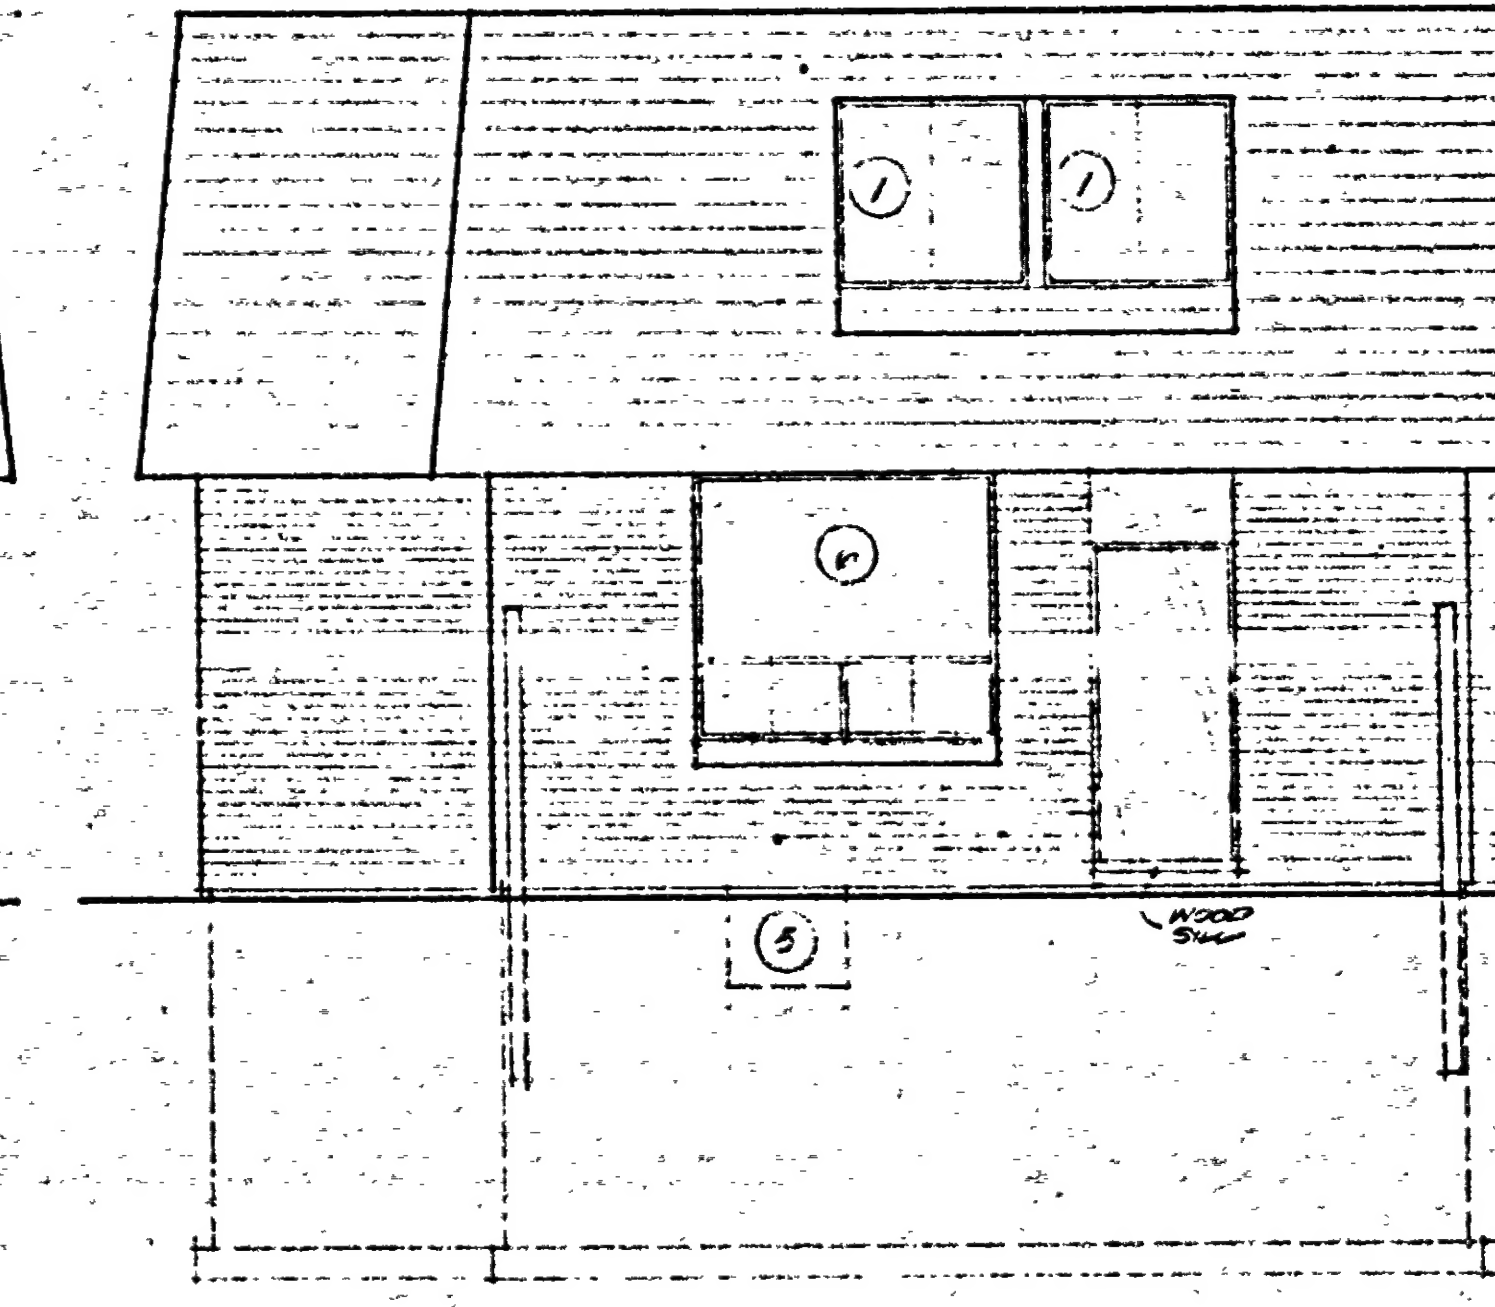


BACK ELEVATION

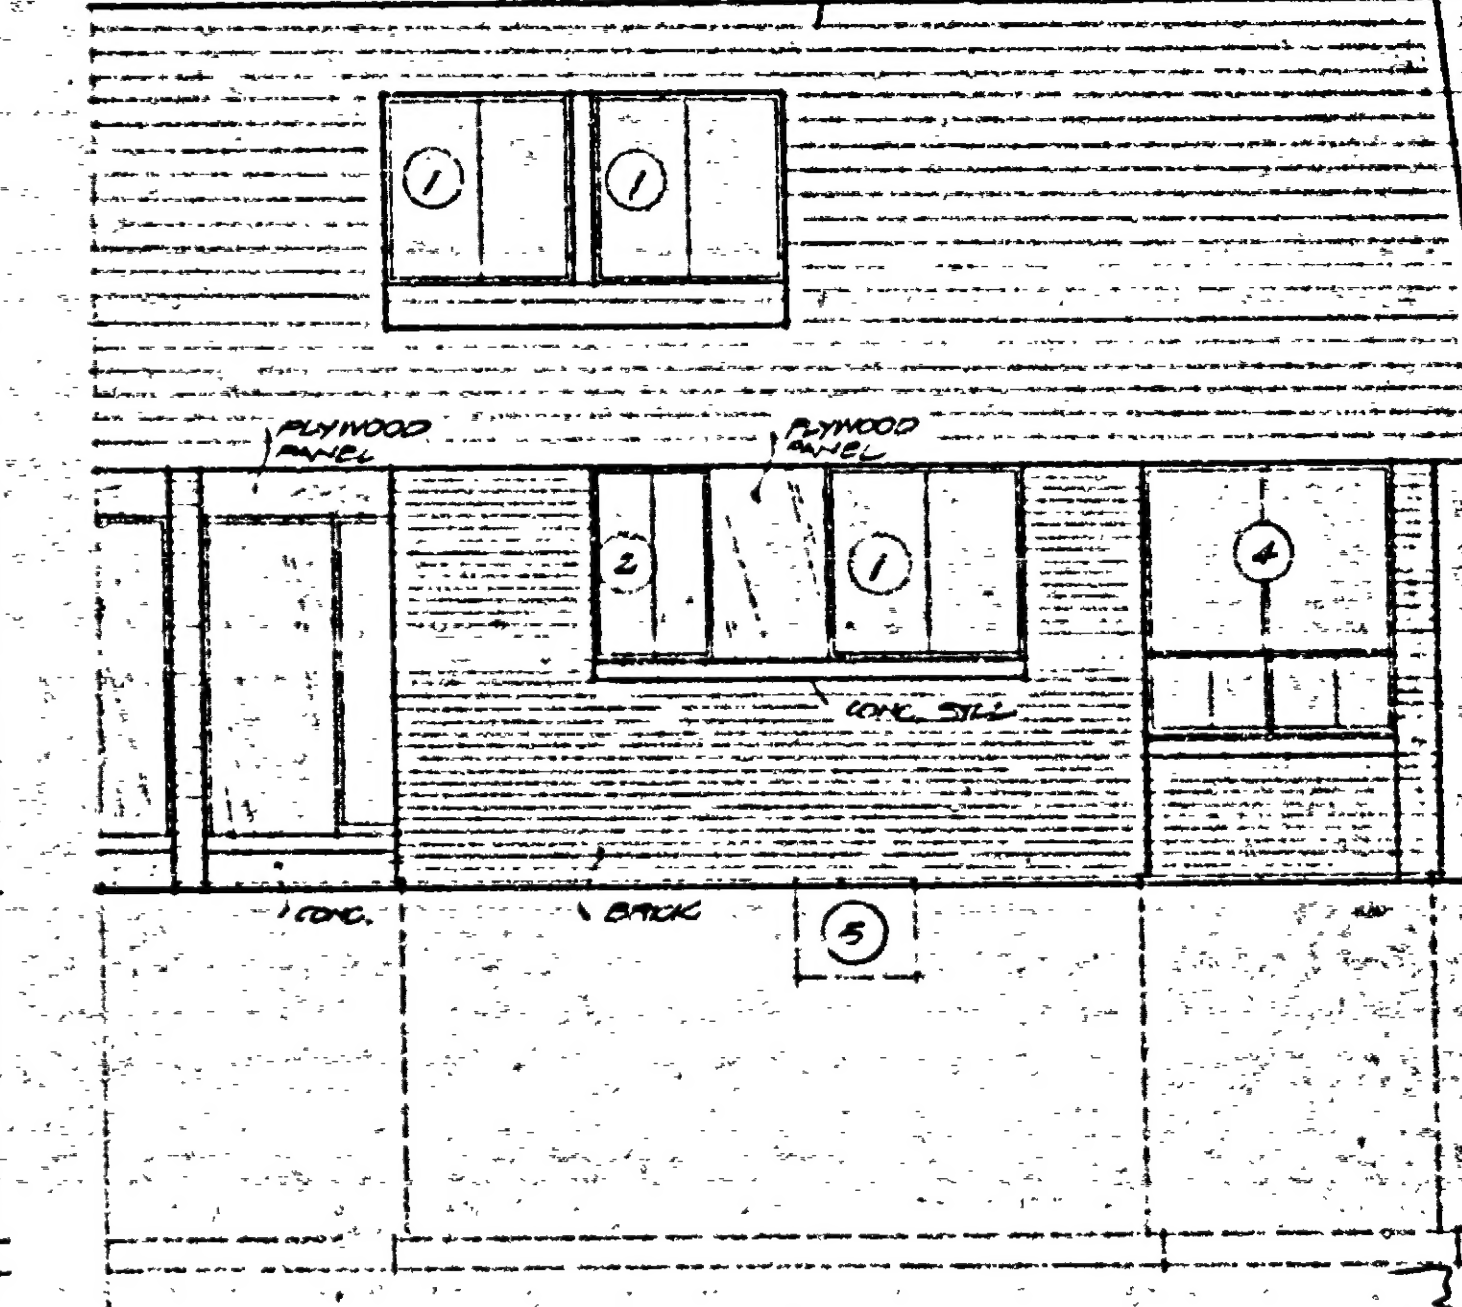


FRONT ELEVATION

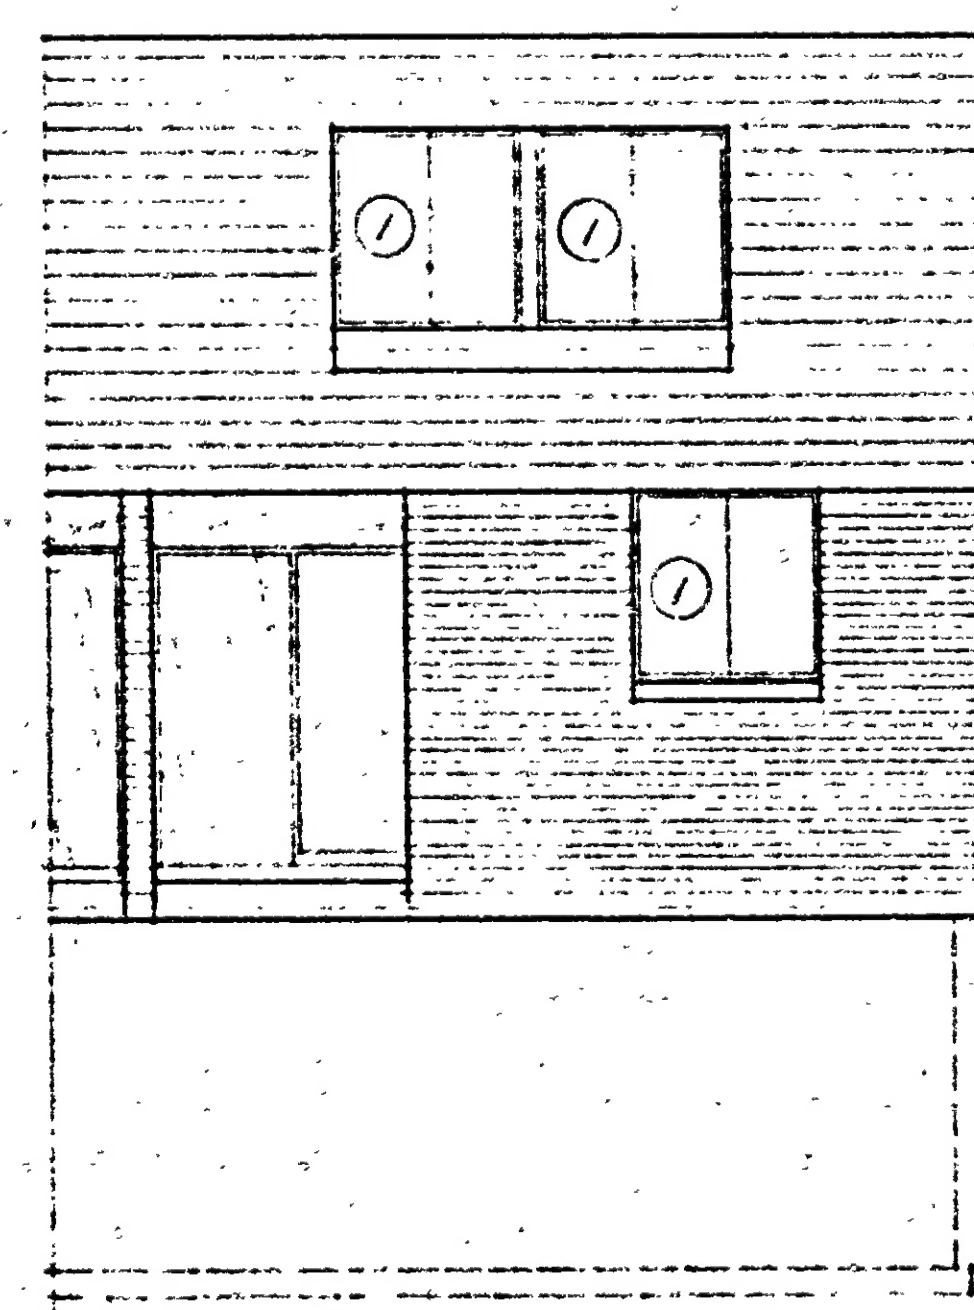


FRONT ELEVATION
 TWO BEDROOM UNITS

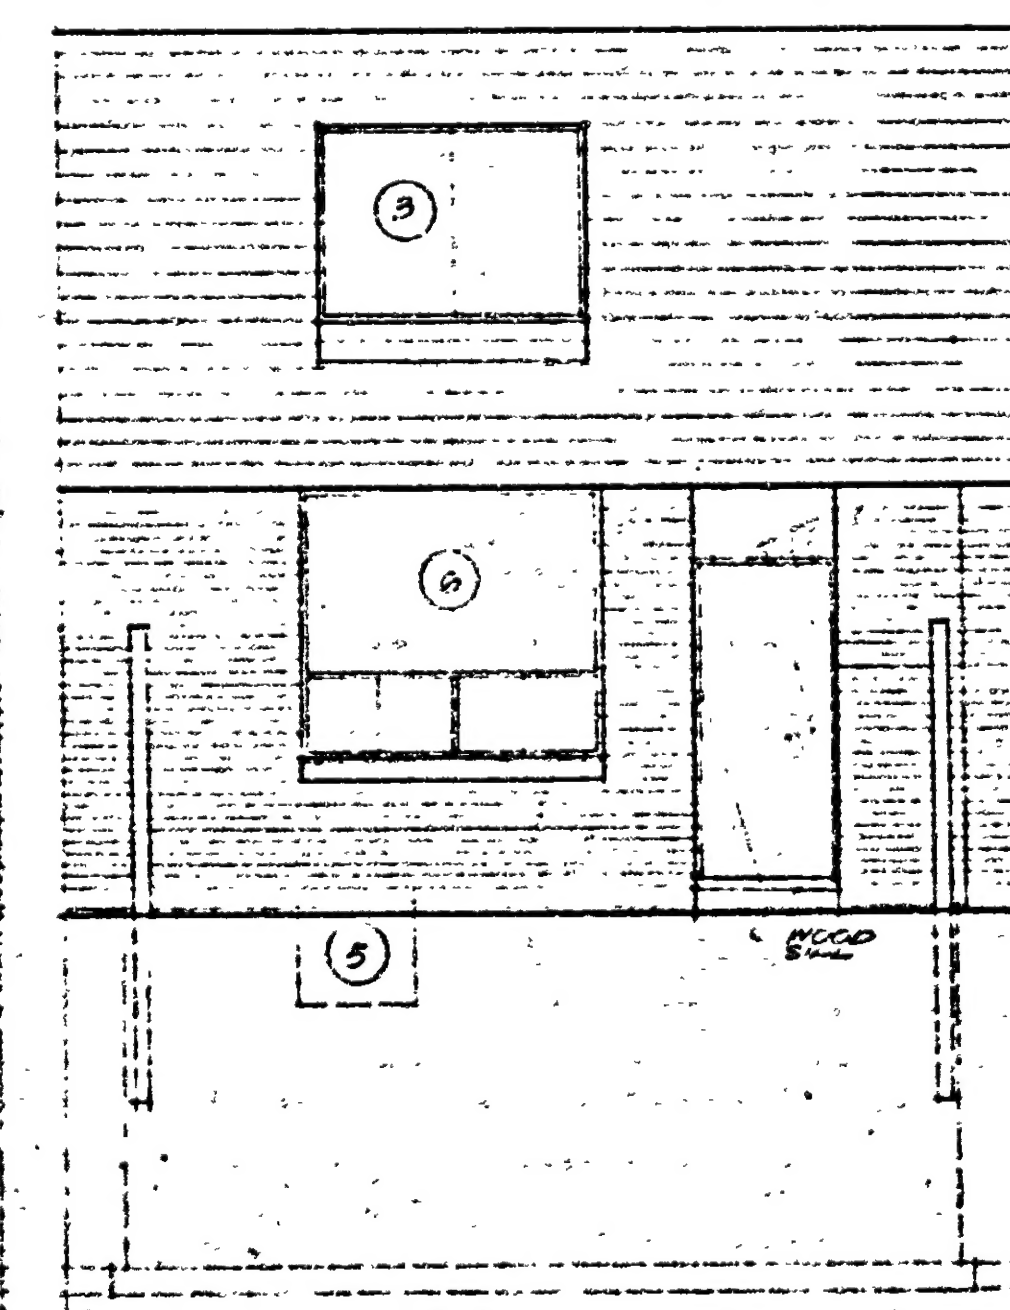


BACK ELEVATION

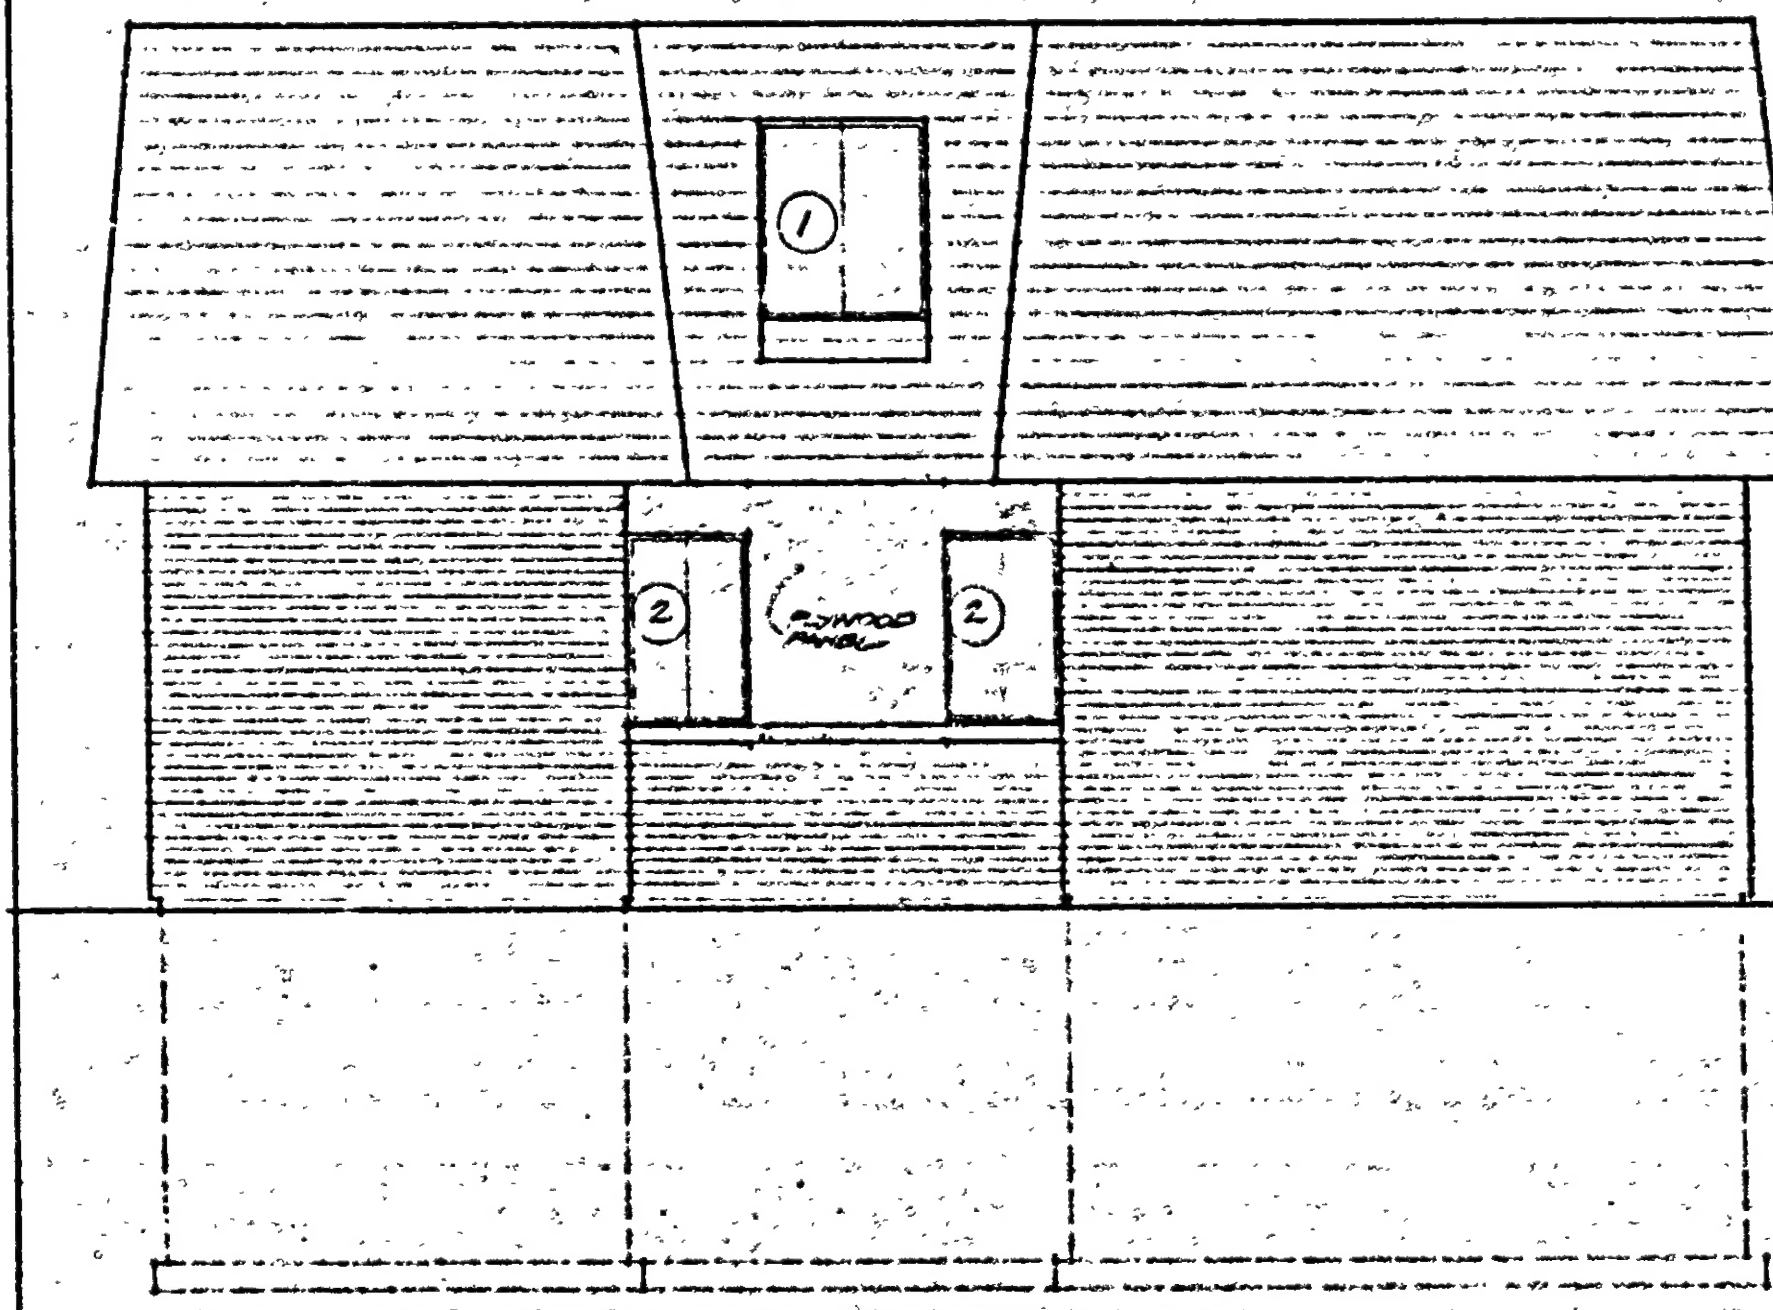

END ELEVATION
 FOUR BEDROOM UNITS

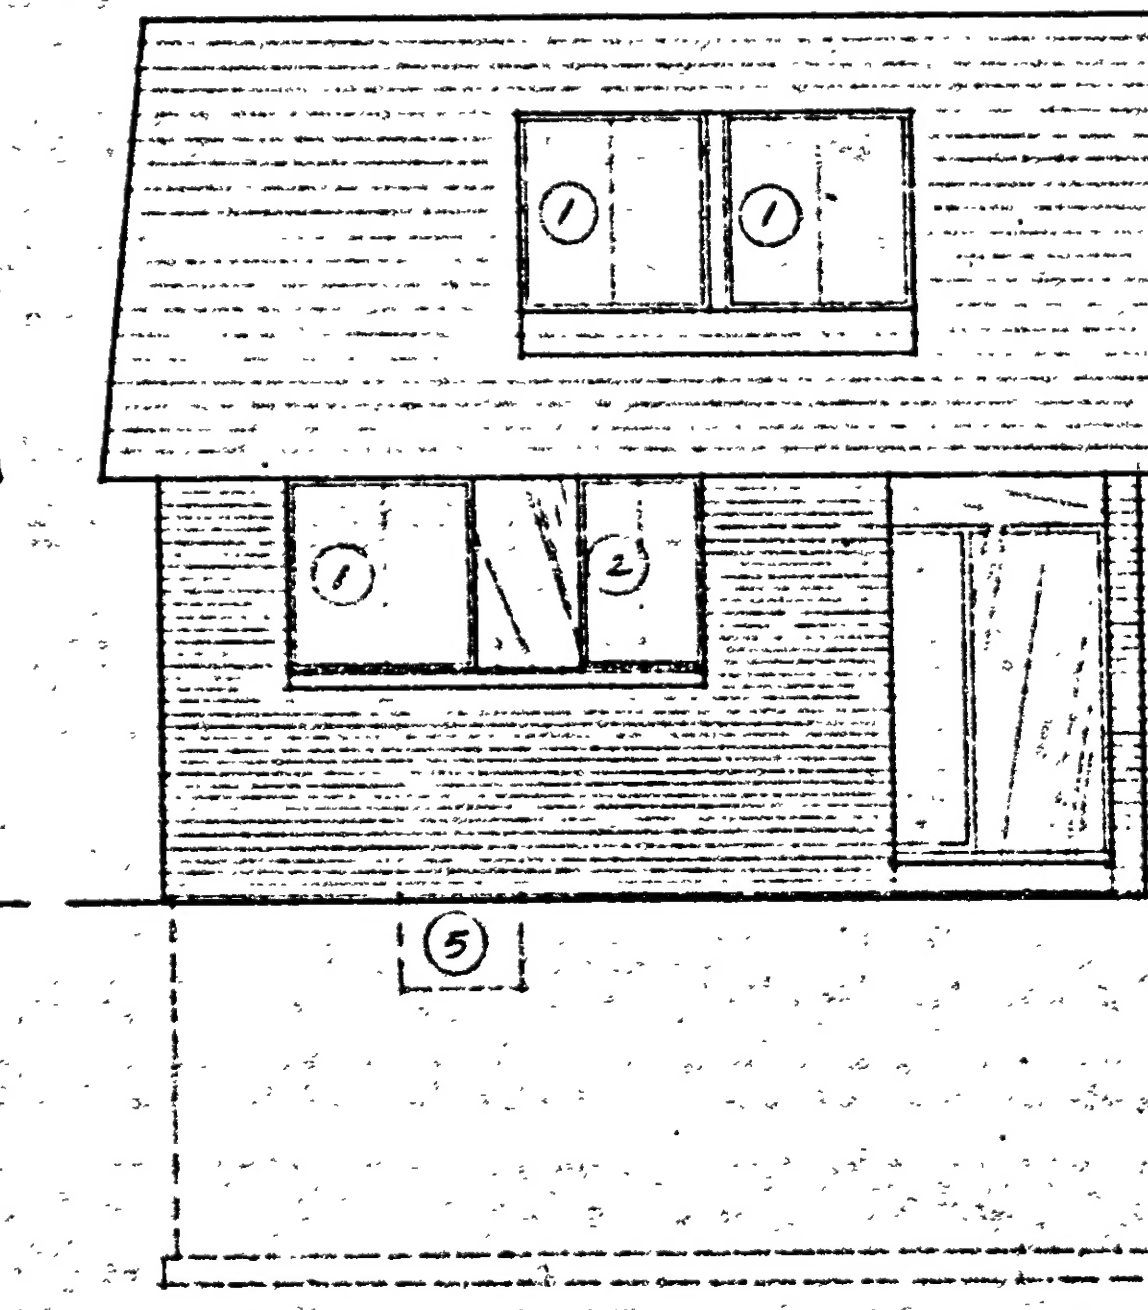

FRONT ELEVATION

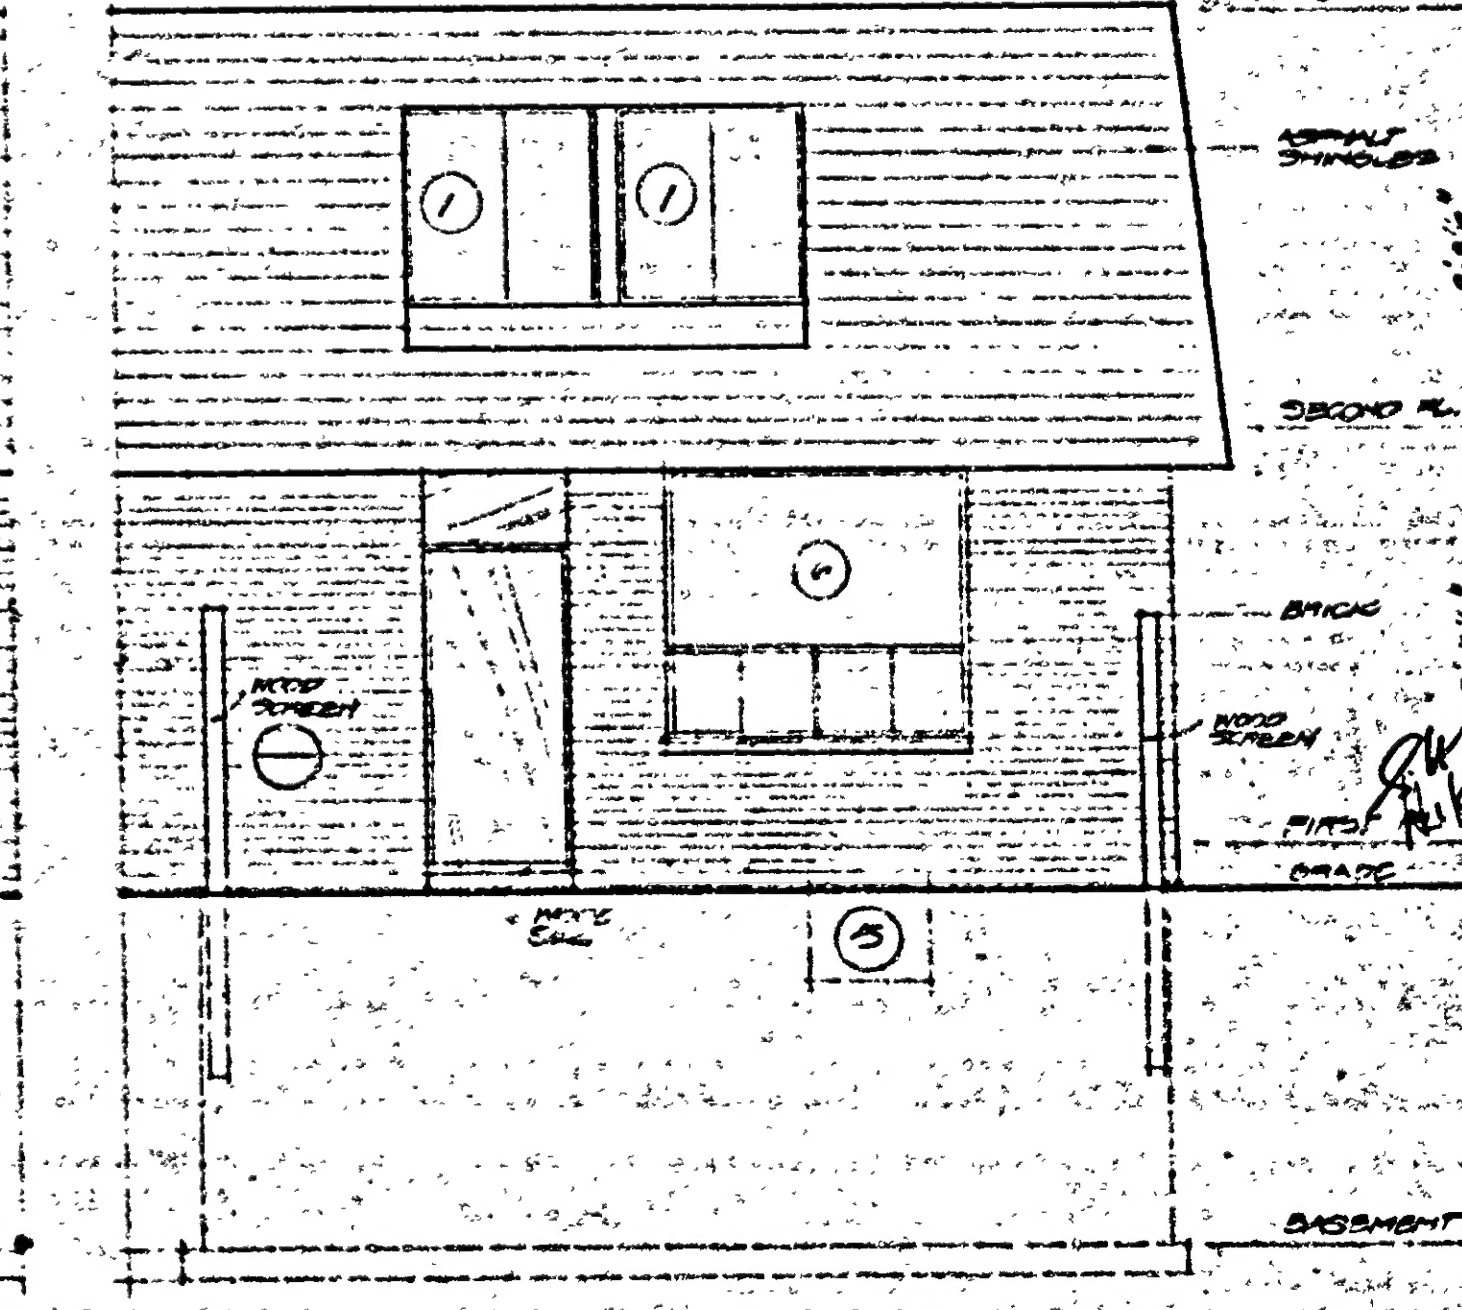

BACK ELEVATION

ELEVATIONS - M3108-A04

ONTARIO HOUSING CORPORATION
 FAMILY HOUSING PROJECT
 SHERBROOKE ST. PETERBOROUGH
 CHARLES HUFFMAN LTD - PETERBOROUGH
 GENERAL CONTRACTOR

WILLIAM LETT - ARCHITECT
 45 COLBORNE ST. TORONTO L. TEL. 346-5682
 SCALE 1/4" = 1'-0"
 DATE MAY 11, 1970
 PROJECT NO. 8802

DRAWING NO.
5
 OF NINE

